

SYMBOL LEGEND	
WIRING RUN IN WALL OR CEILING	S WALL MOUNTED SINGLE POLE SWITCH
WIRING RUN IN FLOOR	3 WALL MOUNTED THREE WAY SWITCH
CEILING MOUNTED LED LINEAR FIXTURE	W WALL MOUNTED DIMMER SWITCH
RECESSED MOUNTED LED LINEAR FIXTURE	F FIRE ALARM BREAKGLASS STATION
CEILING MOUNTED LED LINEAR FIXTURE W/BATTERY PACK	FIRE ALARM GONG
WALL MOUNTED LED FIXTURE	FIRE ALARM BUZZER
SURFACE MOUNTED LED FIXTURE	E FIRE HORN/STROBE
RECESS MOUNTED LED FIXTURE	E FIRE HORN
WALL MOUNTED LED FIXTURE	F FIRE STROBE
LED LIGHT 2X2	M FIRE ALARM ISOLATOR MODULE
LED LIGHT 2X4	D FIRE ALARM HOLD-OPEN DEVICE
LED LIGHT 4FT	S SMOKE DETECTOR
LED TRACK LIGHT	135°F FIRE ALARM HEAT
PUCK LIGHTS	200°F FIRE ALARM HEAT
PENDANT LIGHTS	SA CEILING MOUNTED 120V SMOKE ALARM
CEILING MOUNTED EXIT LIGHT	SC CEILING MOUNTED 120V COMBINATION SMOKE/CO ALARM
WALL MOUNTED EXIT LIGHT	EMERGENCY BATTERY PACK C/W LED LAMPS
WALL MOUNTED EXIT LIGHT WITH EMERGENCY LAMPS	REMOTE EMERGENCY LED HEADS
SITE LIGHTING FIXTURE	T THERMOSTAT
MONPOINT TRACK LIGHT	MOTOR
3" IN-GROUND LED	DISCONNECT SWITCH
CEILING MTD COMPACT FLUORESCENT FIXTURE	MOTOR STARTER
WALL MTD COMPACT FLUORESCENT FIXTURE	H BASEBOARD HEATER
RECESSED MTD COMPACT FLUORESCENT FIXTURE	J JUNCTION BOX
RECESSED STEP LIGHT	TV WALL MOUNTED TELEVISION OUTLET
WALL MOUNTED DUPLEX RECEPTACLE	T TIMER
WALL MOUNTED SWITCHED RECEPTACLE	R RECESS MOUNTED PANELBOARD
WALL MOUNTED GFCI DUPLEX RECEPTACLE	SP SURFACE MOUNTED PANELBOARD
GFCI 20A T-SLOT DUPLEX RECEPTACLE, COUNTER HEIGHT	DED DEDICATED CIRCUIT
20A T-SLOT DUPLEX RECEPTACLE, COUNTER HEIGHT	VAC VACUUM
SPLIT-FEED DUPLEX RECEPTACLE, COUNTER HEIGHT	CEILING MOUNTED HID FIXTURE
WALL MOUNTED FOURPLEX RECEPTACLE	WALL MOUNTED HID FIXTURE
WEATHERPROOF DUPLEX RECEPTACLE (GFCI)	3" DIA. POT LIGHT
FLOOR MOUNTED DUPLEX RECEPTACLE	WALL MOUNTED VACANCY SENSOR
FLOOR MOUNTED TELEPHONE/DATA OUTLET	WALL MOUNTED OCCUPANCY SENSOR
WALL MOUNTED TELEPHONE OUTLET	CEILING MOUNTED OCCUPANCY SENSOR
SPECIAL RECEPTACLE 220V SINGLE PHASE	
WALL MOUNTED TELEPHONE/DATA OUTLET	
WALL MOUNTED DATA OUTLET	
TELEPHONE/TELEVISION COMBO OUTLET	

(1/4") (SYMBOL-14SEP2018)

nick milkovich architects inc	
Suite 303, 375 West 5th Avenue Vancouver, BC, Canada V6Y 1J6 e-mail: hmilko@milkovicharchitects.com web: www.milkovicharchitects.com	
tel 604.737.6061 fax 604.737.6091	
consultant	
LIJEW ENGINEERING LTD. Electrical Consulting Engineers 108-11121 Horseshoe Way Richmond, BC, V7A 5G7 Tel/Fax: 604-277-3157 Email: rliewengltd@telus.net	
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PROFESSIONAL PROVINCE OF R. V. LIJEW # 11872 BRITISH COLUMBIA ENGINEER	
issued	FOR BUILDING PERMIT 25SEP19
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CITY OF RICHMOND	
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key plan

THE CITY HAS RELIED EXCLUSIVELY ON THE
UNDERSTANDING AND AGREEMENT FOR
THE ACCURACY OF THE PLANS IN CONFORMANCE
WITH THE CURRENT EDITION OF THE B.C.
BUILDING CODE IN REVIEWING THE PLANS
SUBMITTED WITH THIS APPLICATION FOR A
BUILDING PERMIT.
R.V. LIJEW
REGISTERED PROFESSIONAL
PERMIT ISSUED BY DATE

project title
INDIA CULTURAL CENTRE
OF CANADA
8600 NO. 5 ROAD,
RICHMOND, B.C.

drawing title


SITE PLAN

City of Richmond Building Approvals City review of documents stamped: Permit No. 19-875824-00	
1. does not relieve the Owner of Lands referred to in this document from full responsibility for work being carried out in compliance with City and Provincial enactments;	
2. is subject to terms and conditions printed on the permit and prescribed in the City bylaw.	
Reviewed by:	Date:

ALL ELECTRICAL DRAWING ISSUED FOR REVIEW
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drawn	project north
checked	RVK
scale	
drawing date	19JUL9
project no.	1909
rev.	E 1

THESE PLANS MUST BE KEPT ON
THE JOB-SITE FOR INSPECTIONS

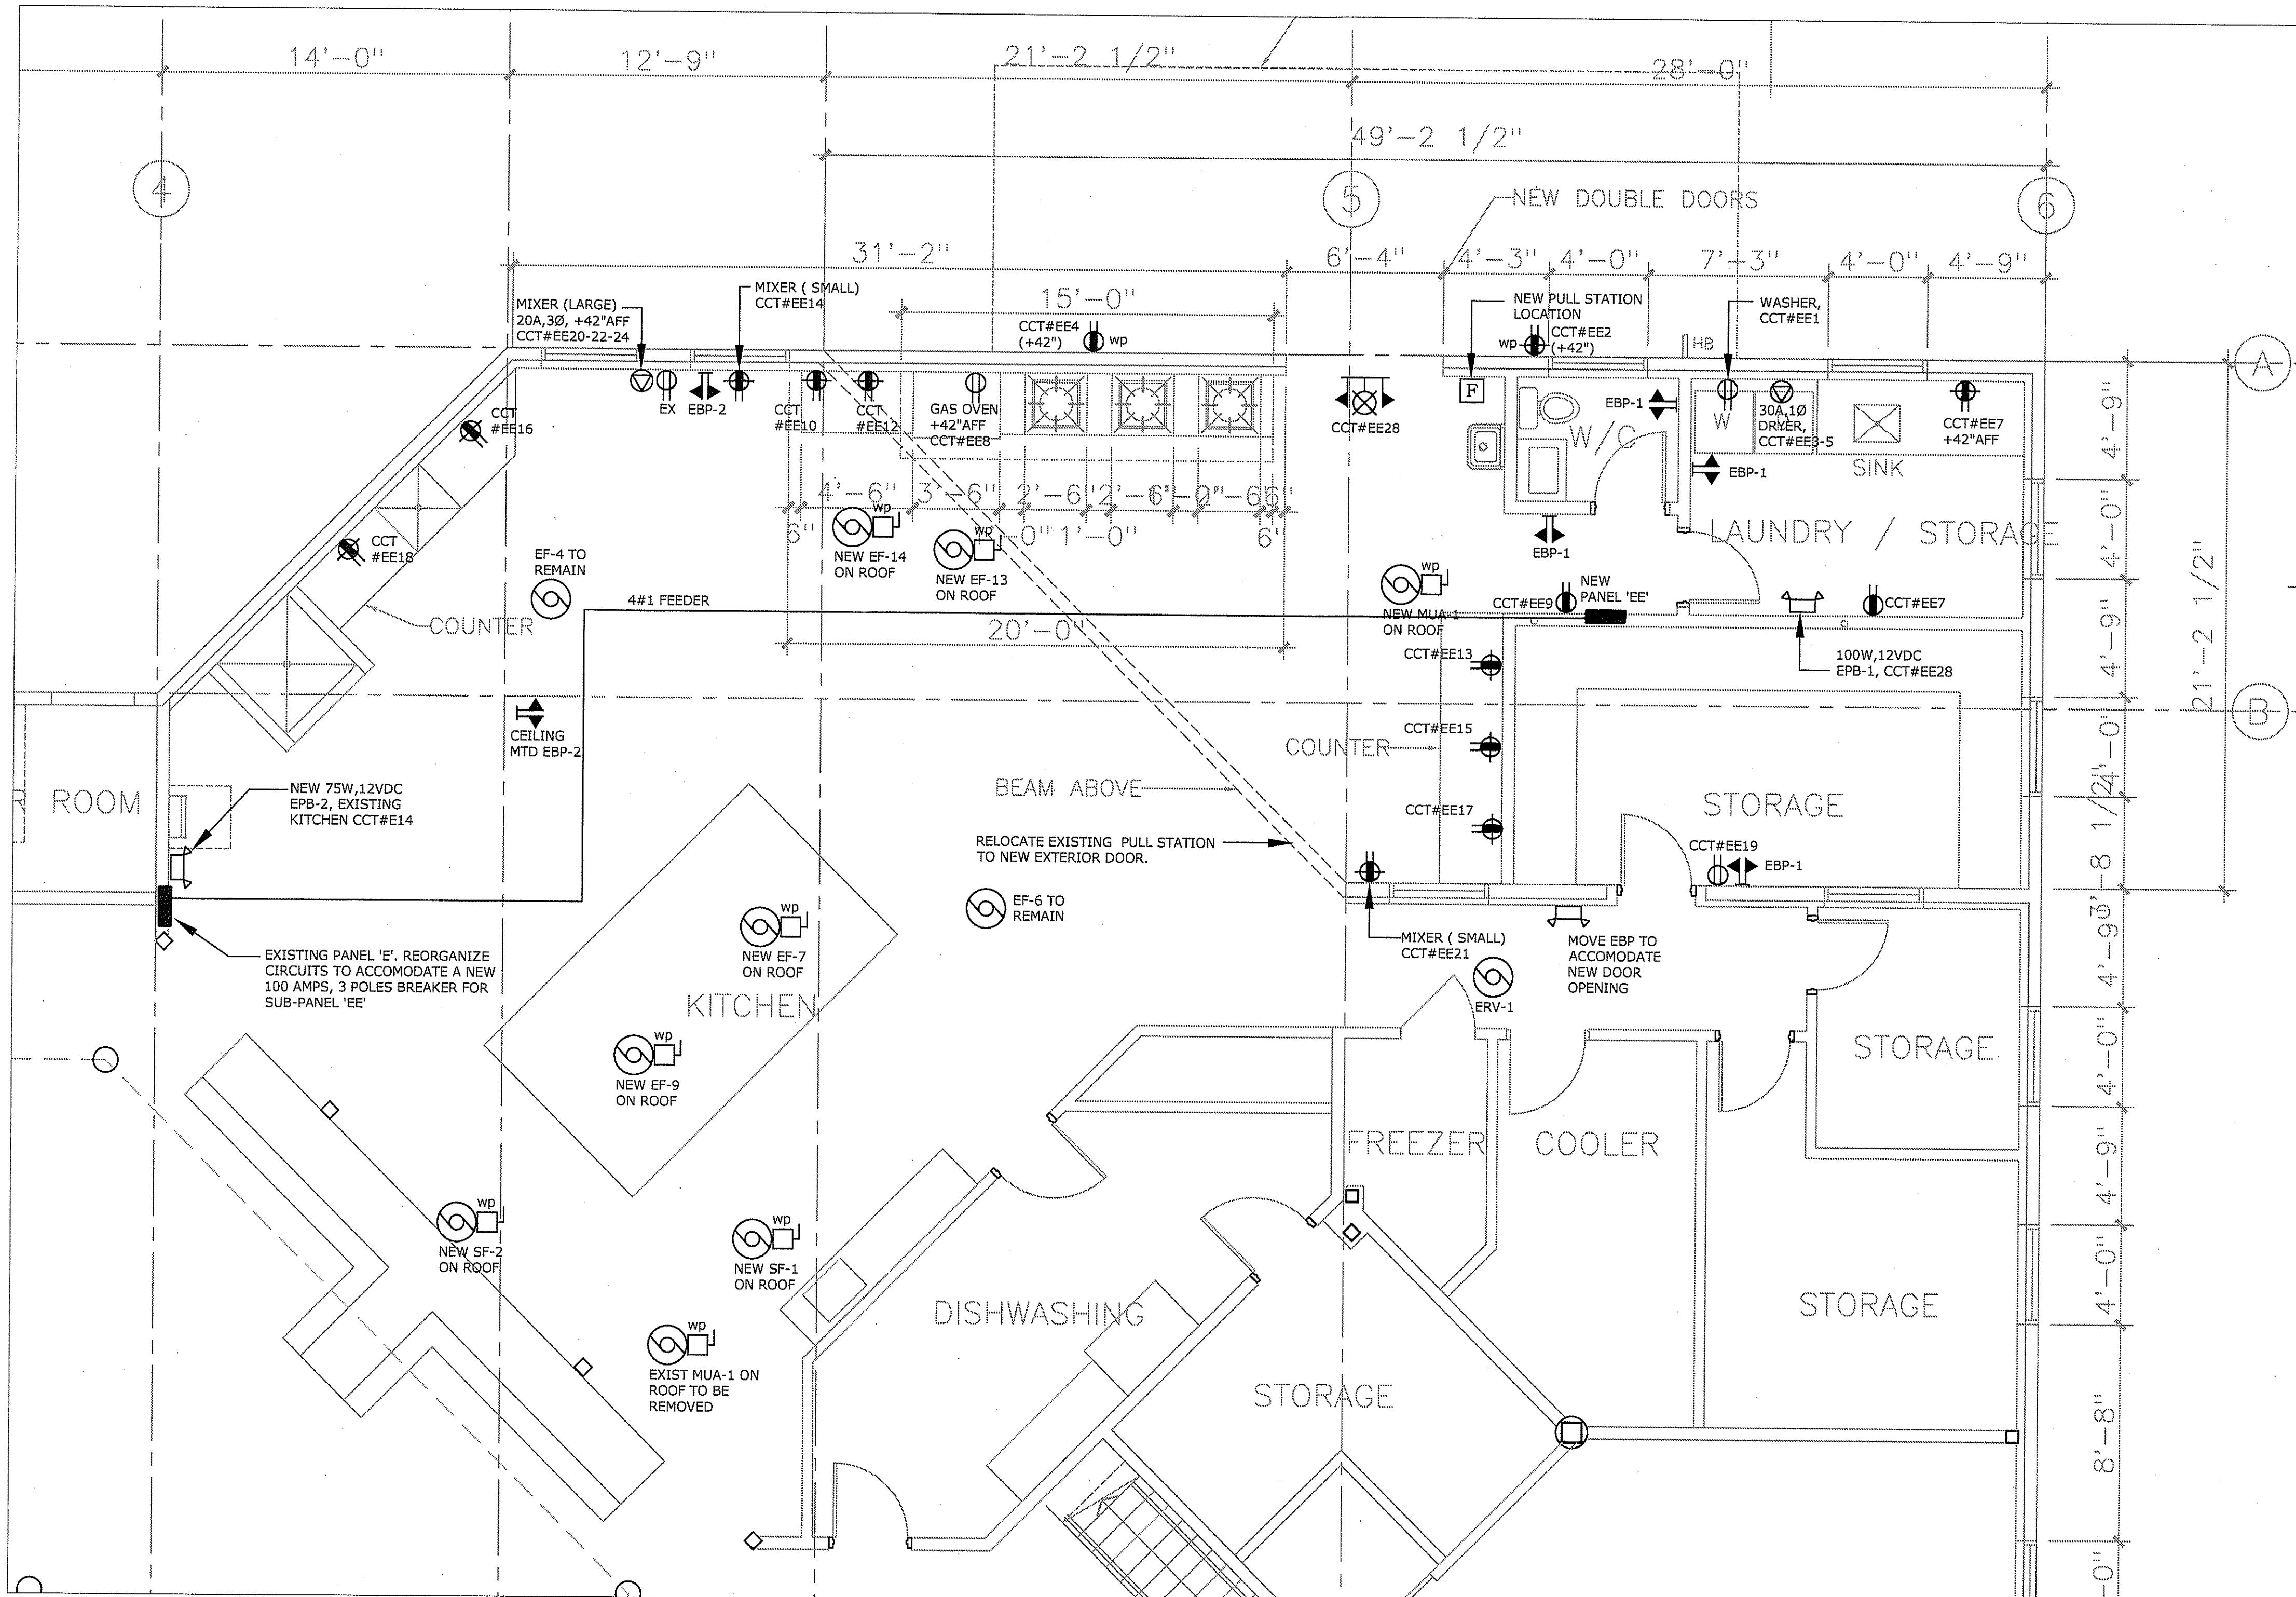

PART PLAN - POWER LAYOUT

Scale: 1/4" = 1'-0"

PANEL EE, 120/208 VOLTS 3 Ø 4 w					
BUS 100 A BKR 10,000 A.I.C.					
LOAD	TRIP	CIRC	CIRC	TRIP	LOAD
WASHER	15	1	2	20	REC-EXTERIOR
DRYER	30	3	4	20	REC-EXTERIOR
2P		5		6	
REC-LAUNDRY	15	7	8	15	GAS OVEN
REC-CORRIDOR	15	9	10	20	REC-COUNTER
		11	12	20	REC-COUNTER
REC-COUNTER	20	13	14	20	MIXER (SM)
REC-COUNTER	20	15	16	20	REC-COUNTER
REC-COUNTER	20	17	18	20	REC-COUNTER
REC-STORAGE RM	15	19	20	20	
MIXER (SM)	15	21	22	3P	MIXER (LG)
		23	24	3P	
		25	26		
		27	28	15	LIGHTING
		29	30	15	ERV-1
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PNL-42


ABBREVIATION
LTG - LIGHTING
REC - RECEPTACLE

nick milkovich
architects inc

Suite 303, 375 West 5th Avenue
Vancouver, BC, Canada V5Y 1J6
e-mail: mma@milkovicharchitects.com
web: www.milkovicharchitects.com

consultant

LIEW ENGINEERING LTD.
Electrical Consulting Engineers
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Richmond, BC, V7A 5G7
Tel/Fax: 604-277-3157
Email: rliewg ltd@telus.net

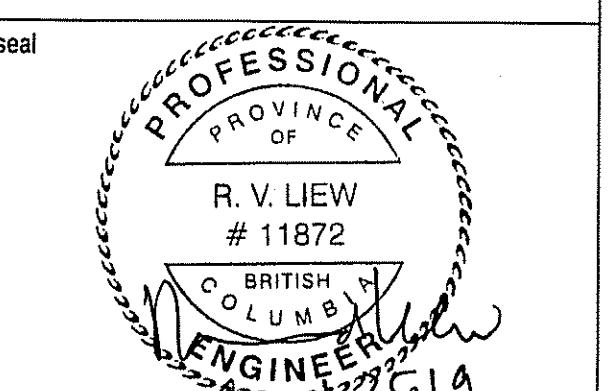

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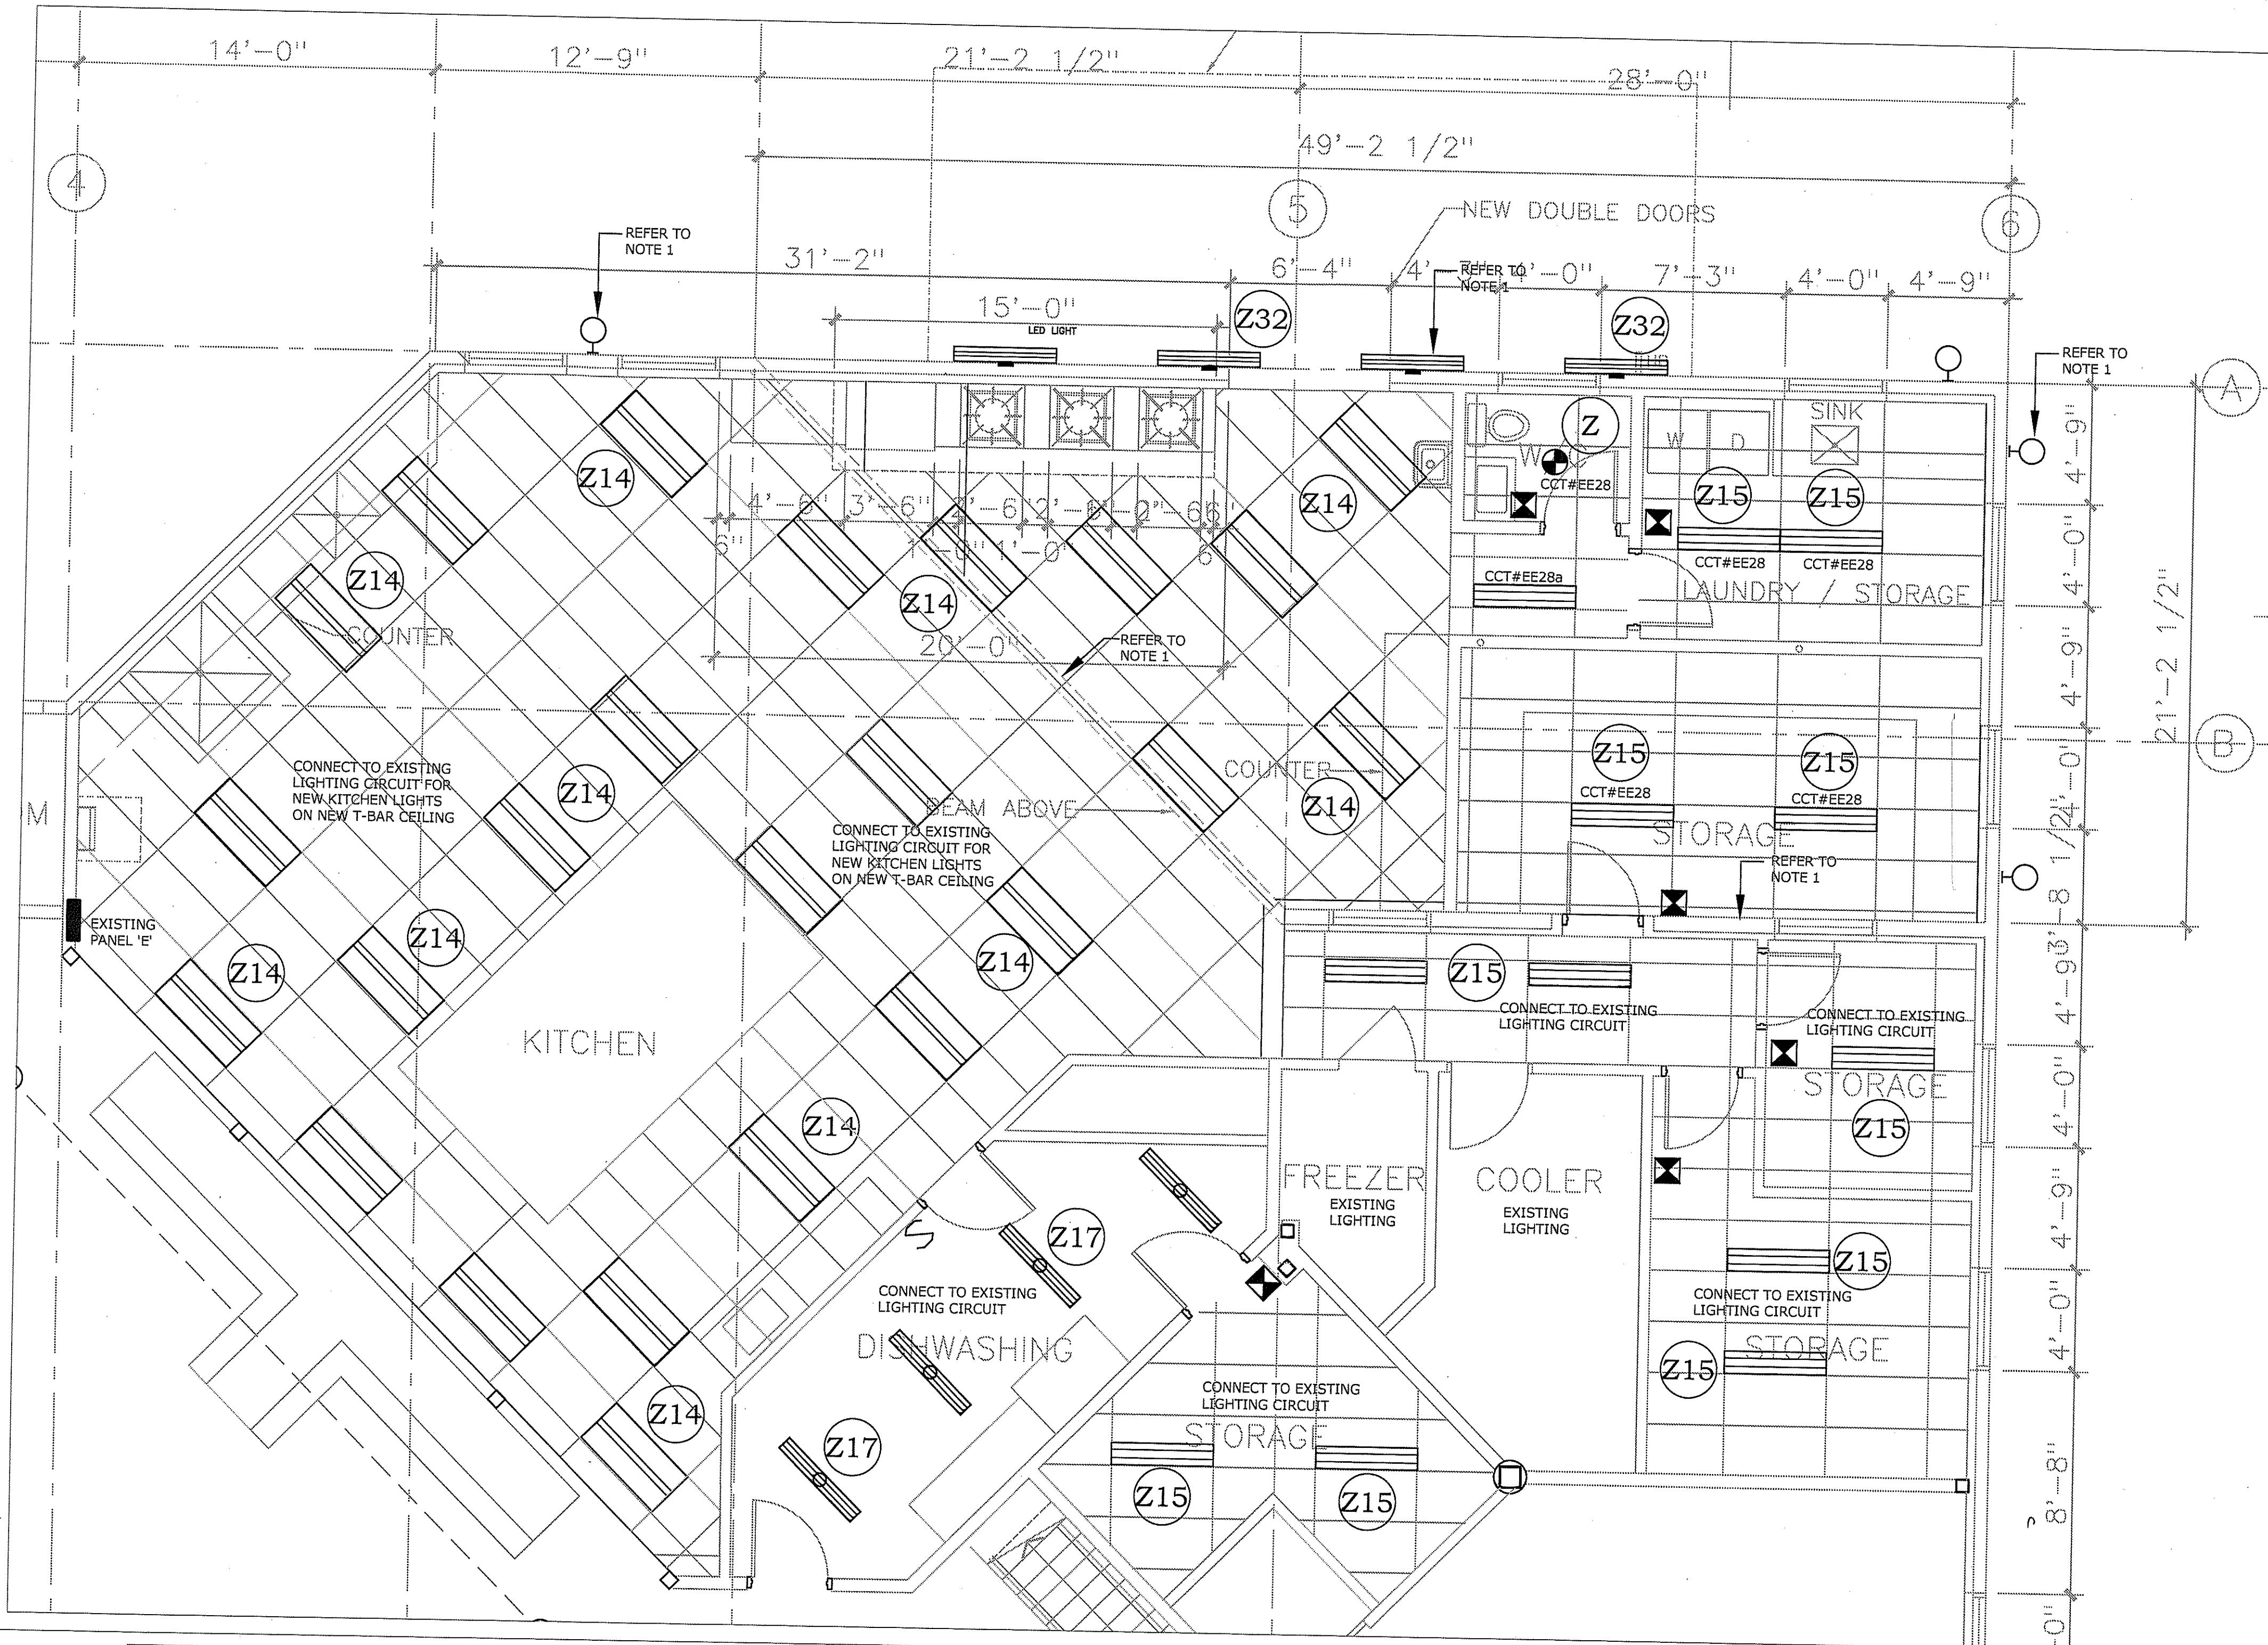
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POWER LAYOUT AND
DETAILS

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Suite 303, 375 West 5th Avenue
Vancouver, BC, Canada V5Y 1J6
e-mail: nma@milkovicharchitects.com
web: www.milkovicharchitects.com

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Suite 303, 375 West 5th Avenue
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Tel/Fax: 604-277-3157
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25SEP19

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INDIA CULTURAL CENTRE
OF CANADA
8600 NO. 5 ROAD,
RICHMOND, B.C.

drawing title
**LIGHTING LAYOUT
AND DETAILS**

drawn
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RVK
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drawing date
19JUL9
printed
project no.
1909
drawing no.
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LUNINAIRE SCHEDULE

TYPE	DESCRIPTION	CAT. NO:	VOLT	NO. OF LAMP	TYPE OF LAMP	NOTE
Z	LED, SLIM SURFACE DOWNLIGHT, ONE PIECE PLASTIC FLANGE INJECTION MOULDED WHITE, HIGH TRANSMITTANCE LENS, DIMMABLE, LISTED DAMP LOCATIONS UNDER COVERED CEILING, ENERGY STAR CERTIFIED.	SIGNIFY LIGHTOLIER S7R837K	120		LED SIGNIFY STRIP, 1000 LUMENS 14 WATTS, 2700K	
Z14	LED, 2' X 4' FLAT PANEL, RECESSED IN INSULATED CEILING OR SURFACE MOUNT, DIMMING DRIVER.	EATON METALUX 24FP LED	120		38W, 4000 LMS, 3500K	
Z15	LED, 1' X 4', T-BAR RECESS MOUNTING, DIMMING DRIVER.	EATON METALUX 14FP LED	120		3400 LUMENS, 32 WATT, 3500K	
Z17	LED, 4" X 4" SURFACE MOUNTED, LED DRIVER, ROUND SEMI-FROSTED LENS, WHITE. (a) = WITH BUILT-IN SENSOR, (d) = STEP DIMMING WITH SENSOR, (e) = WITH 7 WATTS EMERGENCY BATTERY PACK 960 LUMENS, 30 MINUTES.	EATON METALUX 4SNLED-LD5-30SL-LN	120		LED, 3000 LUMENS, 21 WATT, 3500K, 141.2LM/W	
Z32	LED, VAPOR TIGHT, SURFACE MOUNT, MEDIUM DISTRIBUTION M FIBREGLASS HOUSING & GASKETTED CLEAR DIFFUSER SECURED BY CAM LATCHES, INTERNAL PRISMATIC LENS, LED DRIVER STANDARD 0-10V DIMMING.	EATON METALUX 4VT2-LD4	120		38W, 4000 LMS, 3500K	

LIGHTING LAYOUT PLAN

Scale: 1/4" = 1'-0"



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CITY OF RICHMOND

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key plan

project title
INDIA CULTURAL CENTRE OF CANADA 8600 NO. 5 ROAD, RICHMOND, B.C.

drawing title

ELECTRICAL
SPECIFICATIONS

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SPECIFICATIONS

1) **SCOPE**
DIV.26 TO PROVIDE ALL LABOUR, MATERIALS & EQUIPMENT UNLESS SPECIFICALLY NOTED OTHERWISE TO COMPLETE & PUT IN OPERATING CONDITION ALL ELECTRICAL SYSTEMS AS INDICATED ON THE DRAWING & SPECIFIED HEREIN. ANY WORK & OR DETAIL EVEN IF NOT SHOWN OR SPECIFIED, WHICH ARE OBVIOUSLY NECESSARY OR REASONABLY IMPLIED TO COMPLETE THE WORK & OR MEET THE CODE REQUIREMENTS SHALL BE DONE AS IF BOTH SHOWN & SPECIFIED.

2) **MATERIALS & WORKMANSHIP**
ALL MATERIALS TO BE NEW, OF MINIMUM QUALITY SPECIFIED, & BEAR CSA APPROVAL. ALL WORK TO BE PERFORMED BY COMPETENT TRADESMEN, IN WORKMANLIKE MANNER. CLEAN UP ALL DEBRIS AT COMPLETION OF THIS PROJECT.

3) **CODES, PERMITS & INSPECTIONS**
INSTALLATION SHALL COMPLY WITH THE 2018 CURRENT EDITION OF THE CANADIAN ELECTRICAL CODE, GOVERNING BRITISH COLUMBIA BUILDING CODE 2018 & REGULATIONS OF THE ELECTRICAL INSPECTION AUTHORITY. OBTAIN PERMITS & PAY THE APPLICABLE FEES. AFTER COMPLETION OF THE WORK, FURNISH TO THE ENGINEER A CERTIFICATE OF FINAL INSPECTION & APPROVAL FROM THE INSPECTION DEPARTMENT.

4) **VISIT TO SITE (MANDATORY)**
EXAMINE THE SITE & LOCAL CONDITIONS AFFECTING THE WORK BEFORE SUBMITTING TENDER. NO EXTRAS WILL BE ALLOWED FOR WORK RESULTING FROM CONDITIONS WHICH WOULD HAVE BEEN EVIDENT UPON A THOROUGH EXAMINATION OF THE SITE.

5) **APPROVALS**
SUBSTITUTION OF MATERIALS, EQUIVALENT TO THOSE SPECIFIED, MAY BE MADE ONLY AFTER WRITTEN APPROVAL HAS BEEN OBTAINED FROM THE ENGINEER BEFORE CLOSING OF TENDERS.

6) **GUARANTEE**
DIV.26 SHALL GUARANTEE THE SATISFACTORY OPERATION OF ALL WORK & APPARATUS INSTALLED UNDER THIS CONTRACT & SHALL REPLACE FORTHWITH, AT HIS OWN EXPENSE, ANY PART WHICH MAY FAIL OR PROVE DEFECTIVE WITHIN A PERIOD OF 12 MONTHS AFTER FINAL ACCEPTANCE OF THE COMPLETE CONTRACT, ALWAYS PROVIDED THAT SUCH FAILURE IS NOT DUE TO IMPROPER USAGE OR ORDINARY WEAR & TEAR.

7) **DRAWINGS & SPECIFICATIONS**
SHOULD ANY DISCREPANCY APPEAR ON THE DRAWINGS & SPECIFICATIONS, WHICH LEAVES DOUBT AS TO THE INTENT & MEANING, OBTAIN A RULING FROM THE ENGINEER BEFORE SUBMITTING TENDER. FAILING THIS, ALLOW FOR MOST EXPENSIVE ALTERNATIVE OR REASONABLE ALTERNATIVE TO COMPLETE THE WORK.

8) **CO-ORDINATION**
DRAWINGS INDICATE GENERAL LOCATION & ROUTE TO BE FOLLOWED BY CONDUIT & OR WIRE. FOLLOW ARCHITECTURAL, STRUCTURAL & MECHANICAL DRAWINGS FOR DETAILS OF THIS WORK & INSTALL ELECTRICAL CONDUIT, BOXES & FITTINGS TO CO-ORDINATE WITH ARCHITECTURAL, STRUCTURAL & MECHANICAL WORK & DETAILS. REFER TO ARCHITECTURAL & STRUCTURAL DRAWINGS FOR ACCURATE DIMENSIONS.

9) **LOCATION OF OUTLETS**
ENGINEER RESERVES THE RIGHT TO CHANGE LOCATION OF OUTLETS TO WITHIN 10' OF POINTS INDICATED ON PLANS WITHOUT EXTRA CHARGE PROVIDING DIV.16 IS ADVISED PRIOR TO INSTALLATION.

10) **MOUNTING HEIGHTS**
UNLESS OTHERWISE NOTED ON THE DRAWINGS OR IN THE SPECIFICATIONS, MOUNTING HEIGHTS FOR ELECTRICAL DEVICES TO BE AS FOLLOWS:

SWITCHES - 48" AFF
RECEPTACLES - 12" (UNO)
TELEPHONE OUTLETS - 12" (UNO)
EMERGENCY LAMPS - 96" AFF
MANUAL PULLSTATION - 47" AFF
FIRE BELL - 9" AFF

11) **SHOP DRAWINGS**
SUBMIT SHOP DRAWINGS OF ELECTRICAL COMPONENTS WHERE REQUIRED & INDICATED HEREIN.

12) **RECORD DRAWINGS**
MAINTAIN IN THE JOBSITE A SET OF PLANS & RECORD ALL CHANGES IN RED, TURN DRAWINGS MARKED "AS-BUILT" OVER TO THE ARCHITECTS AFTER COMPLETION OF THE PROJECT.

13) **MECHANICAL EQUIPMENT WIRING**

a) PROVIDE POWER WIRING TO ALL MECHANICAL EQUIPMENT AS SHOWN ON THE DRAWINGS & OR EQUIPMENT SCHEDULE. PROVIDE MANUAL & MAGNETIC STARTERS FOR MOTORS, FANS & EQUIPMENT AS INDICATED ON THE DRAWINGS & OR EQUIPMENT SCHEDULE. PROVIDE DISCONNECT SWITCHES FOR MOTORS, FANS & EQUIPMENT AS SHOWN ON THE DRAWINGS & OR EQUIPMENT SCHEDULE. PROVIDE CONDUIT & WIRING TO ALL LINE VOLTAGE CONTROL DEVICES & MAKE FINAL CONNECT AT BOTH ENDS.

b) ALL LOW VOLTAGE WIRING UNLESS SPECIFICALLY NOTED OTHERWISE WILL BE THE RESPONSIBILITY OF DIV.15. ALL CONTROL DEVICES LIKE PRESSURE SWITCHES, FLOW SWITCHES, THERMOSTATS, HUMIDISTAT, etc. WILL BE SUPPLIED & INSTALLED BY DIV.15. FAN CONTROLS LIKE ON/OFF & SPEED CONTROLLERS WILL BE SUPPLIED BY DIV.15 & INSTALLED BY DIV.16. INTERLOCKING DEVICES LIKE RELAYS, SWITCHES & WIRING BETWEEN EQUIPMENT WILL BE THE RESPONSIBILITY OF DIV.15.

14) **WIRING METHODS**

a) WIRE ALL SYSTEMS IN THE BUILDING IN CONDUIT EXCEPT AS FOLLOWS:
- NMD FOR BRANCH CIRCUIT WIRING IN WOOD FRAME PARTITIONS ONLY;
- ARMoured CABLE FOR BRANCH CIRCUIT WIRING IN STEEL FRAME PARTITIONS;
- FLEXIBLE CONDUIT WITH GTF WIRE FOR FINAL CONNECTIONS TO RECESSED LIGHTING TEMPERATURE RATING OF INSULATION OR LARGER CONDUCTOR SIZE IS REQUIRED. USE WIRE SPECIFICALLY APPROVED FOR THE PURPOSE;
- FLEXIBLE CONDUIT FOR CONNECTIONS TO MOTORS, FANS & OTHER MECHANICAL EQUIPMENT. LIQUID-TITE FOR WET AREAS.

b) GENERALLY & WHERE PERMITTED BY THE CANADIAN ELECTRICAL CODE, USE EMT CONDUIT. USE GALVANIZED RIGID CONDUIT AT ALL LOCATIONS WHERE IT IS BOTH EXPOSED & WITHIN 18" OF THE FLOOR PARTICULARLY FOR ALL CONDUIT EMERGING FROM SLABS, COLUMNS, etc. USE GALVANIZED RIGID CONDUIT IN MASONRY AT ALL LOCATIONS WHERE EMT CANNOT OR WILL NOT BE EFFECTIVELY PROTECTED FROM DAMAGE DURING CONSTRUCTION & AT ALL POINTS WHERE CONDUIT EMERGE FROM SLABS, COLUMNS, etc. INSTALL ALL WIRING CONCEALED IN ALL AREAS EXCEPT IN ELECTRICAL AND MECHANICAL ROOMS, REPAIR SHOP AREAS AND STORAGE ROOMS.

c) ALL BUILDING WIRE SHALL BE 98% CONDUCTIVITY COPPER WITH RW90 X-LINK INSULATION. MINIMUM SIZE CONDUCTOR SHALL BE NO.12.

d) ALL DC WIRING TO REMOTE LAMPS FROM BATTERY-PACKS SHALL BE NO.10 AWG WITH HOME RUNS NOT EXCEEDING 2% VOLTAGE DROP.

15) **BOXES**

EXCEPT WHERE NOTED OTHERWISE, BOXES SHALL BE PRERESSED SHEET STEEL, GALVANIZED TO CSA STANDARDS. HANDY BOXES OR SECTIONAL BOXES SHALL NOT BE USED. ALL OUTLETS FOR FLUSH WALL MOUNTING SWITCHES, RECEPTACLES, LOW TENSION, TELEPHONE OUTLETS, etc. SHALL BE NO.52151 WITH APPROPRIATE PLASTER RING FOR SINGLE OR 2-GANG OUTLETS.

16) **SWITCHES**

LINE VOLTAGE SWITCHES SHALL BE QUIET, SLOW MAKE, SLOW BREAK DESIGN, TOGGLE HANDLE WITH TOTALLY ENCLOSED CASE, RATED AT 15-AMPS, 120/277-VOLT AC, SPECIFICATION GRADE TYPE, COLOUR TO BE WHITE. HUBBELL CAT.NO.HBL1201 & HBL1203I FOR 3-WAY SWITCHES.

17) **RECEPTACLES**

a) FULL GANG SIZE, POLARIZED, DUPLEX, PARALLEL BLADE, UNDERGROUND SLOT, RATED AT 15A, 125V, A.C., SPECIFICATION GRADE TYPE, COLOUR TO BE WHITE. HUBBELL CAT.NO.52621.

b) ISOLATED GROUND RECEPTACLES SHALL BE HUBBELL 1G.5262.

18) **PLATES**

A FULL COMPLEMENT OF PLATES SHALL BE PROVIDED FOR SWITCHES & RECEPTACLES. PLATES SHALL BE STAINLESS STEEL TYPE 304 FOR FLUSH MOUNTED DEVICES. USE UTILITY TYPE FOR SURFACE MOUNTED DEVICES. CIRCUIT NUMBERS SHALL BE PROVIDED ON THE FACE OF THE PLATES.

27) **ELECTRICAL EQUIPMENT SHUT-OFF**
EQUIPMENT UNDER THE HOOD, IF ANY, SHALL BE INTERLOCKED WITH THE FIRE SUPPRESSION SYSTEM SO THAT THEY ARE DEACTIVATED WHEN THE SYSTEM OPERATES. THE WIRING TO THE SYSTEM INCLUDING CONNECTION, SHALL BE BY ELECTRICAL CONTRACTOR, CO-ORDINATE WITH THE FIRE SUPPRESSION SYSTEM SUPPLIER. THE CONTROLS INCLUDE CONTACTORS & RELAYS ALL IN AN ENCLOSURE SHALL BE MOUNTED CLOSE BY TO THE FIRE SUPPRESSION SYSTEM.

28) **KITCHEN VENTILATION SYSTEM**
EXISTING EXHAUST FANS ARE BEING REPLACED WITH NEW FANS BY DIV.15. DIV. 26 SHALL CONFIRM ELECTRICAL DATA PRIOR TO RECONNECTING THE FANS. NEW WEATHERPROOF DISCONNECT SWITCHES ARE REQUIRED.

PROVIDE WIRING AND CONNECTIONS TO NEW FANS AS REQUIRED.

TEST SYSTEMS FOR PROPER SEQUENCE OF OPERATION TO MEET CURRENT CODE.

RECONNECT TO EXISTING FIRE ALARM ZONE FOR THE AS REQUIRED AFTER COMPLETION OF WORK RELATED TO THE VENTILATION SYSTEM.

ENSURE ELECTRICAL EQUIPMENT UNDER THE CANOPY ARE SHUT DOWN WHEN HOOD SUPPRESSION SYSTEM IS ACTIVATED.

ALL CONTROL WIRING SHALL BE BY DIV.15

29) **MOTOR STARTERS**

MOTOR STARTERS SHALL BE GROUPED AND MOUNTED IN ELECTRICAL ROOM AND OR ELECTRICAL CLOSETS. STARTERS SHALL BE PROPERLY LABELLED WITH LAMACOID NAMEPLATE. STARTERS SHALL BE PROPERLY SIZED INCLUDING OVERLOAD PROTECTION. USE APPROPRIATE ENCLOSURES FOR THE STARTERS.

COMBINATION STARTERS SHALL INCLUDE A 'HOA' SWITCH & AUXILIARY CONTACTS. WHERE REQUIRED, PROVIDE REMOTE 'HOA' SWITCH IN PROPER HOUSING FOR RECESS MOUNTING.

VARIABLE SPEED STARTERS & VARIABLE FREQUENCY DRIVE STARTERS SHALL BE SUPPLIED BY DIV. 15 & INSTALLATION BY DIV. 26. ALL CONTROL WIRING SHALL BE DIV.15. CONFIRM LOCATION OF STARTERS WITH DIV. 15 PRIOR TO INSTALLATION.

30) **EXTERIOR RECEPTACLES**
RECEPTACLES SHALL BE WEATHERPROOF COMPLETE WITH HINGED COVER, "WHILE-IN-USE" TYPE. ONLY RECEPTACLES ON THE GROUND FLOOR SHALL BE GFCI TYPE. ALL OTHER EXTERIOR RECEPTACLES ABOVE 8FT OF THE GROUND FLOOR SHALL BE STANDARD TYPE RECEPTACLES WITH "WHILE-IN-USE" HINGED COVER.

FOR EXTERIOR APPLICATION, LAMPS SHALL BE READY-LITE 'WT' SERIES DOUBLE HEADS, 12V, 18W TUNGSTEN SEALED BEAM, BLACK COLOUR. PROVIDE CAST ALUMINUM BOX FOR POST MOUNTING AND USE RIGID PVC CONDUIT OR LIQUID-TITE FLEX FOR WIRING.

25) **OCCUPANCY SENSOR/ON/OFF/DIMMABLE**
SENSOR SWITCH SHALL BE SIMILAR TO LUTRON MAESTRO MODEL 'MA' WITH PLATE AND COLOUR TO SUIT WALL FINISHES; DIMMABLE FOR LED LOW VOLTAGE SOURCE.

26) **FIRE ALARM ALARM**
THIS BUILDING HAS AN EXISTING FIRE ALARM SYSTEM. RELOCATE PULL STATION AS SHOWN ON PLANS. ADD NEW DEVICES WHERE SHOWN ON PLANS.

INSTALLATION SHALL COMPLY WITH CAN/ULC S524-01 REGULATIONS. PANEL MUST BE ULC LABELLED IN FRONT OF COVER.

FIRE ALARM EQUIPMENT SUPPLIER TO MAKE A THOROUGH INSPECTION OF THE COMPLETE INSTALLED FIRE ALARM SYSTEM & TO VERIFY THAT ALL THE COMPONENTS & EQUIPMENT ARE CONNECTED & FUNCTION IN ACCORDANCE WITH MANUFACTURER'S RECOMMENDATIONS & ULC REQUIREMENTS. PROVIDE A CERTIFICATE AFTER THE SYSTEM HAS BEEN VERIFIED & PROOF OF LIABILITY INSURANCE VALID FOR NOT LESS THAN ONE YEAR FROM DATE OF FINAL INSPECTION.

VERIFICATION SHALL BE PERFORMED BY AN INDEPENDENT CONTRACTOR LICENCED TO PERFORM SUCH WORK.

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